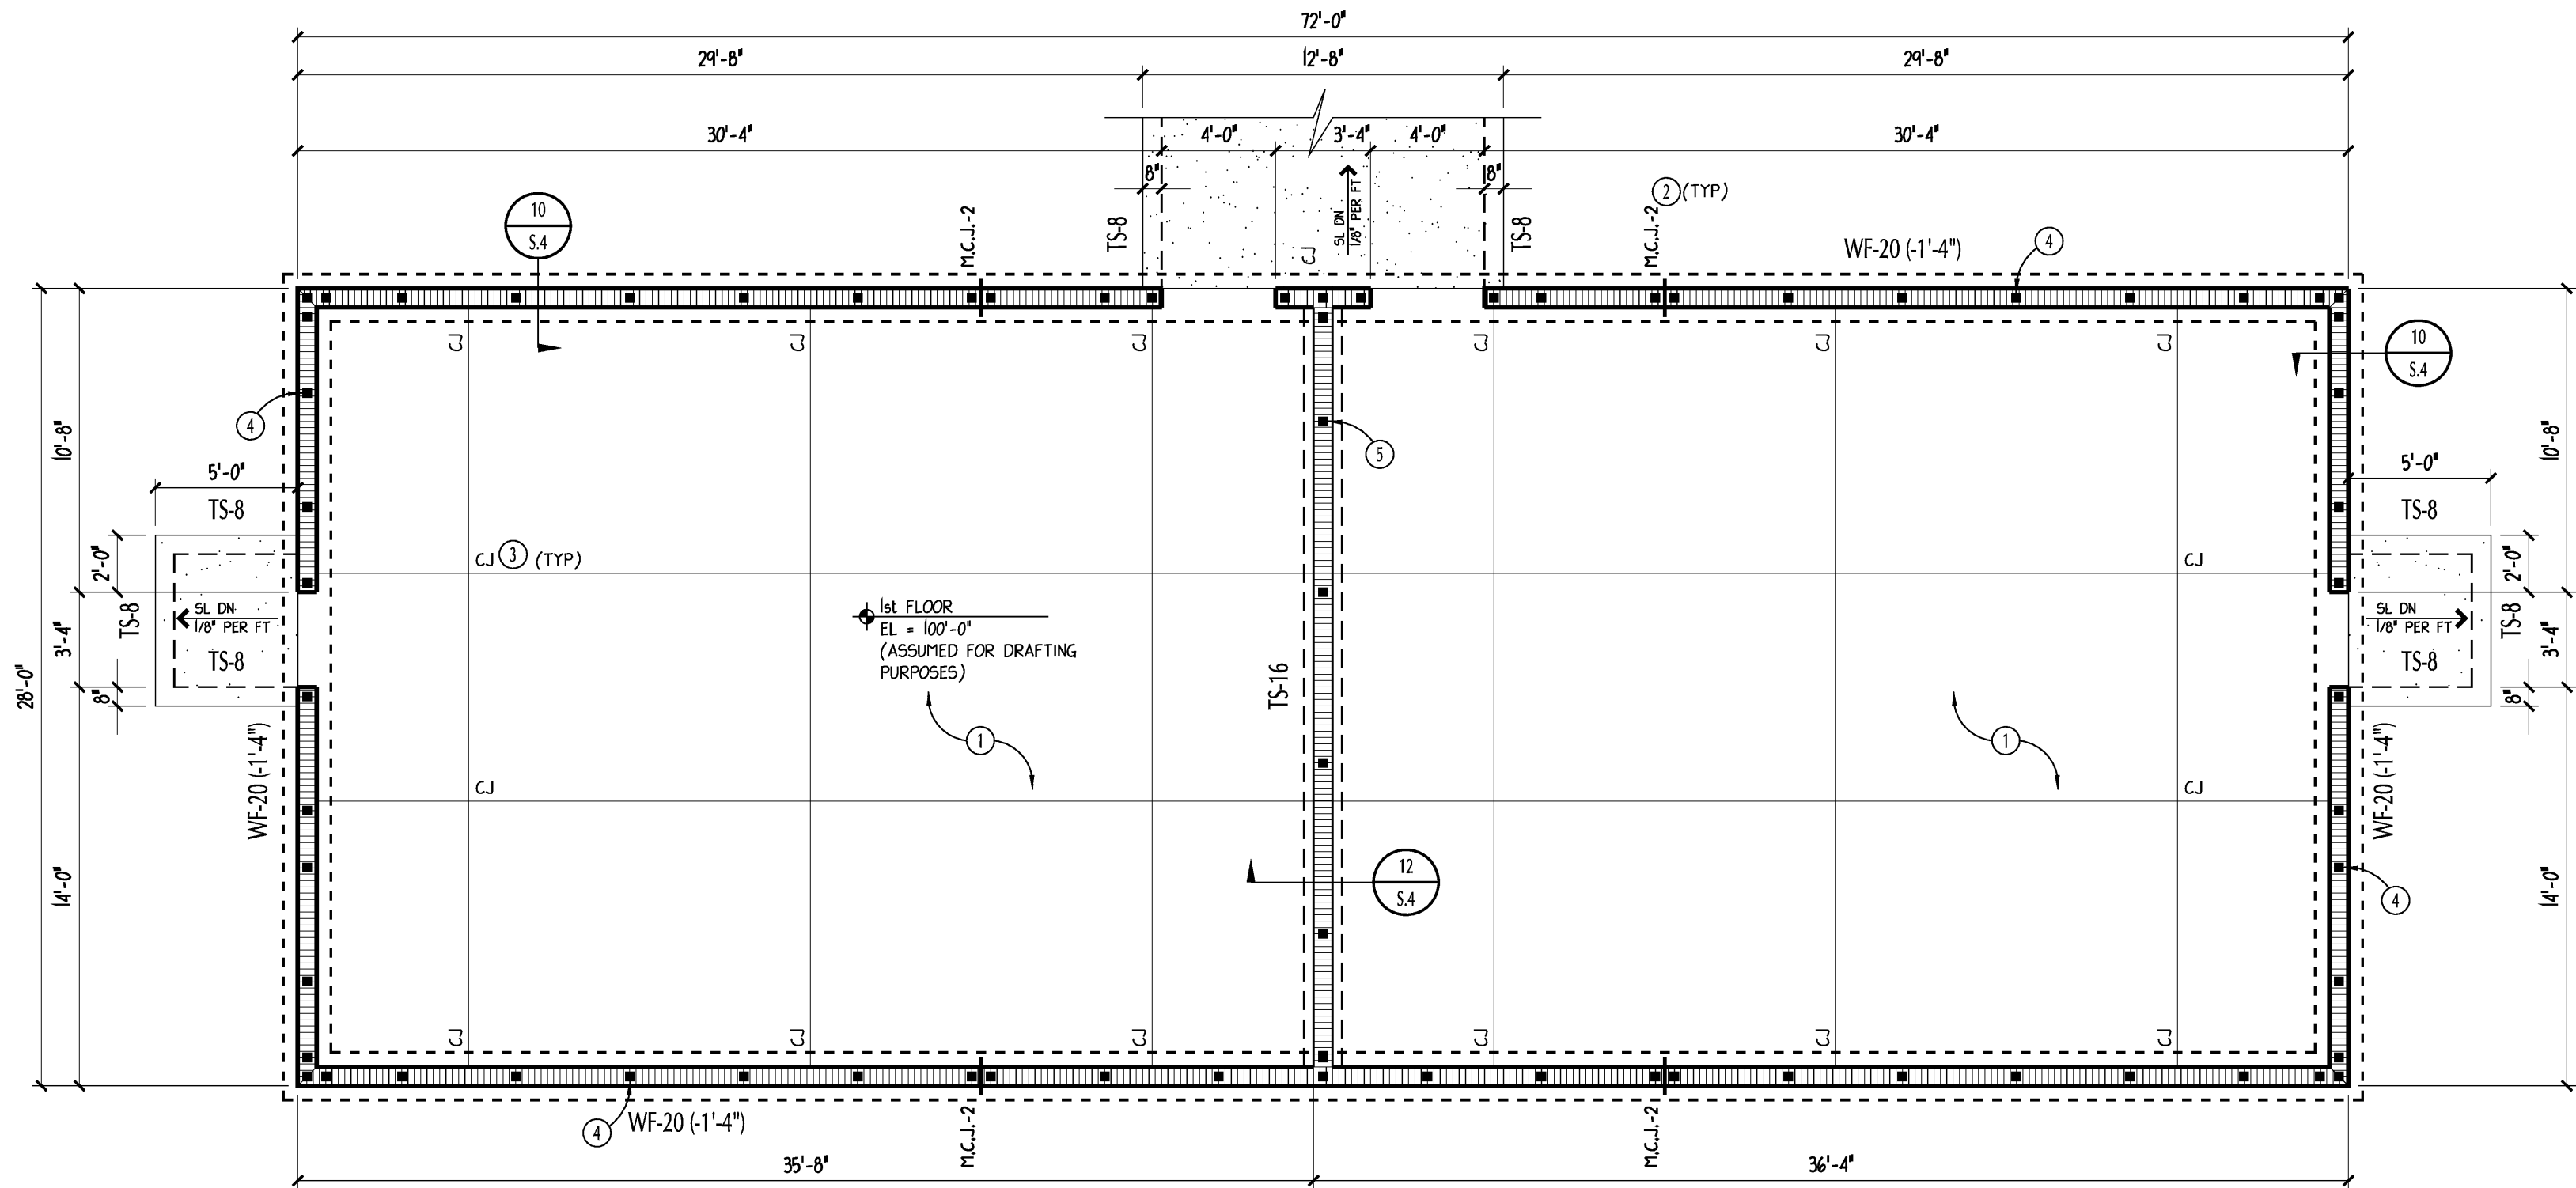


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ANY MODIFICATIONS TO THESE PLANS OR RE-USE OF THESE PLANS MUST BE APPROVED BY AND SIGNED BY THE ARCHITECT.

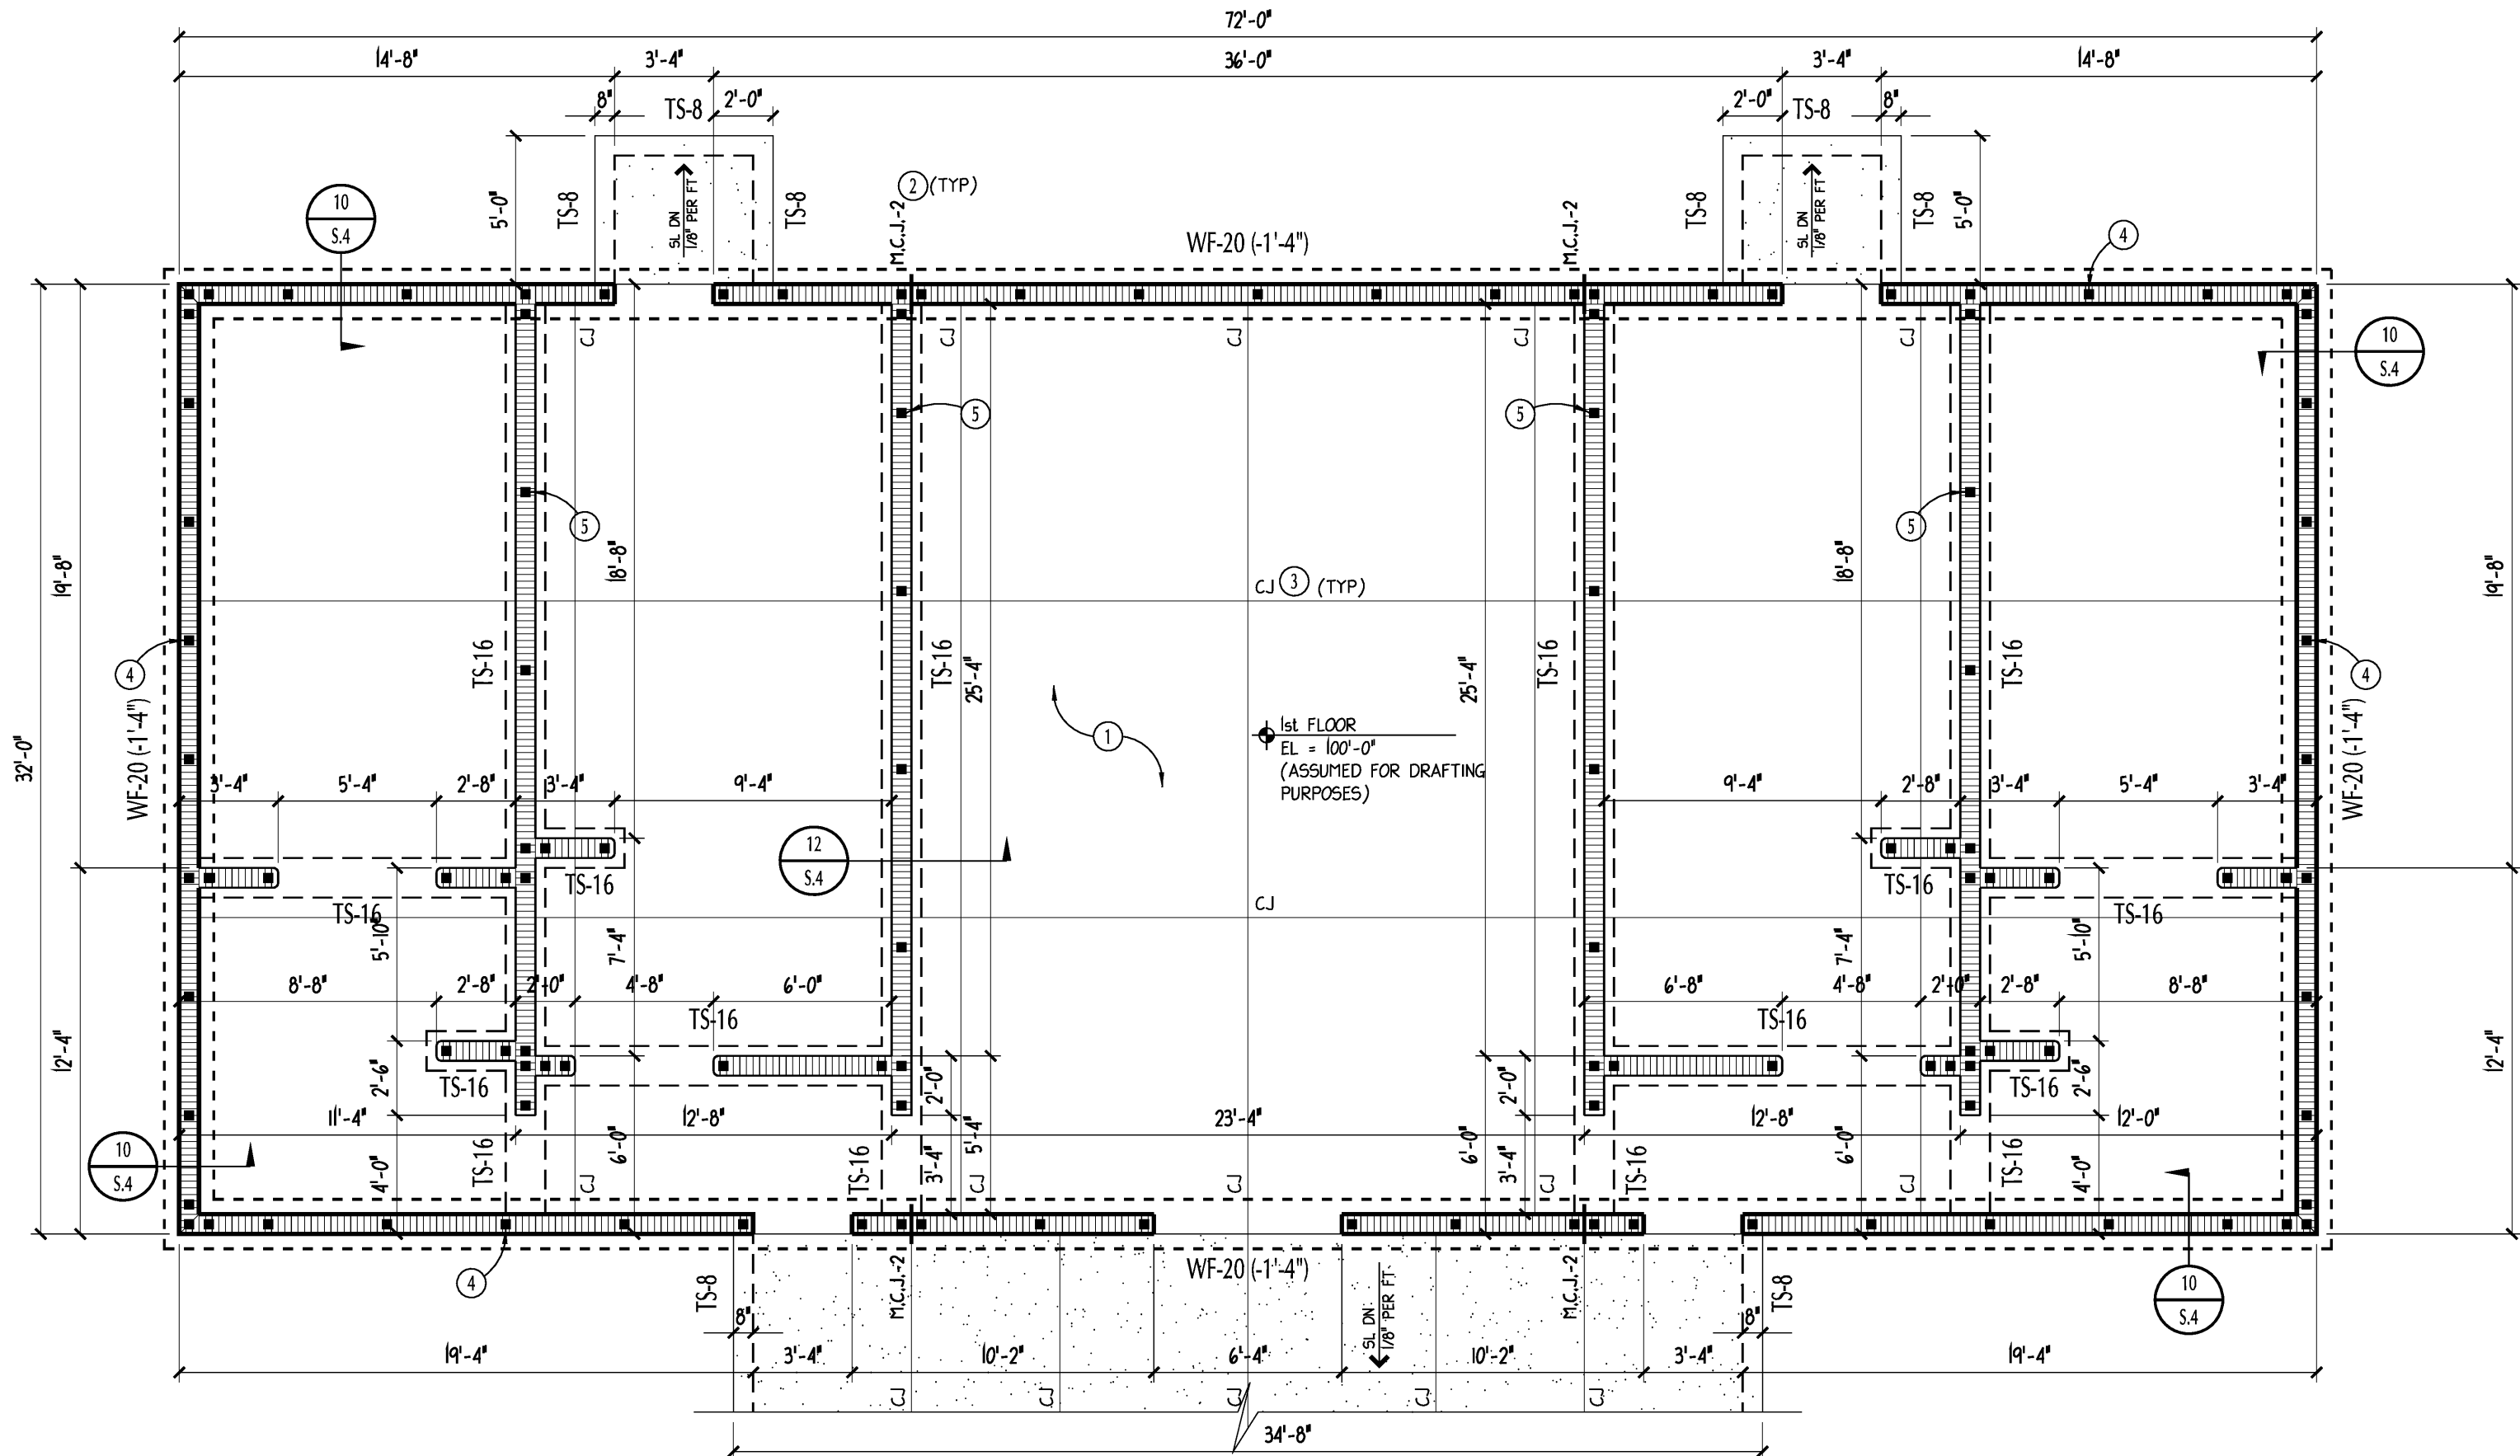
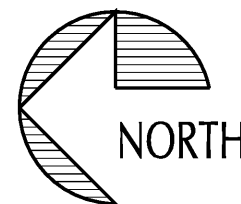
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FOUNDATION PLAN

3/16" = 1'-0"

ALTERNATE - UMPIRES' CABIN BUILDING



FOUNDATION PLAN

3/16" = 1'-0"

ALTERNATE - UMPIRES' SHOWER BUILDING



FOUNDATION PLAN NOTES

- 4" SLAB ON GRADE OVER PREPARED SUB-GRADE AS SPECIFIED. REINF. SLAB W/6X6-W/40X1/4 WIRE MESH @ CL OF SLAB, (OR USE FIBER REINFORCED CONC.) PROVIDE 6 MIL POLYETHYLENE BARRIER BETWEEN SLAB AND SUB-GRADE. (SUB-GRADE TO BE TERRITE TREATED).
- PROVIDE M.C.J. PER PLAN 3/4" GROOVE THROUGH TB/BOND BM @ C.J. COORD. SEE DETAIL 6/5.6
- REFER TO 2/5.4 FOR CONTROL JOINT INFO FOR SLAB ON GRADE.
- TYP 8" C.M.U. WALL REINF. W/ (1) #5 @ 48" O.C. VERT. (UNO). USE LADDER TYPE REINFORCING IN BED JOINTS @ 16" O.C. PER G.N. UNO. ONE #6 BAR @ ALL CORNERS & SIDES OF ALL OPENINGS AT LOAD BEARING EXTERIOR PERIMETER WALLS.
- TYP 8" C.M.U. WALL REINF. W/ (1) #5 @ 72" O.C. VERT. (UNO). USE LADDER TYPE REINFORCING IN BED JOINTS @ 16" O.C. PER G.N. UNO. ONE #6 BAR @ ALL CORNERS & SIDES OF ALL OPENINGS AT NON-LOAD BEARING INTERIOR WALLS.
- USE TS-16 FOR INTERIOR NON-LOAD BEARING WALLS U.N.O.
- INTERIOR WALLS SHALL BE WOVEN TOGETHER AT INTERSECTIONS. SEE 2/5.6 & 4/5.4 FOR BOND BEAM REINF. AT TOP OF WALL. PLACE A BB-8 AT TOP OF ALL NON-LOAD BEARING WALLS.
- AT NON-LOAD BEARING INTERIOR CMU WALLS, USE A CASTCRETE BFB-03 OVER ALL 3'-4" DOOR OPENINGS.

REVISIONS

ITEM

DATE

JOHN H. SOUTHARD

P.E. #57599

SHEET NO.

S.2.4

CITY OF NEWBERRY

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ON 11/1/08

DRAWN BY:

JMA/CSH

DATE:

02/17/11

PROJECT NO.:

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